


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DRAWING TITLE: REFERENCE PLAN ELECTRICAL


E00

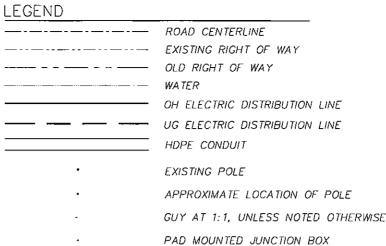

PAD MOUNTED TRANSFORMER

PLAN A PLAN B PLAN F PLAN C PLAN E PLAN D PLAN G PLAN F SEE E002 SEE E003 SEE E009 SEE E004 SEE E006 SEE E005 SEE E008 SEE E007

ELECTRICAL LAYOUT - OWNER PROPOSED ALIGNMENT

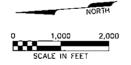

ELECTRICAL SHEET INDEX

E001 REFERENCE PLAN ELECTRICAL LAYOUT PARTIAL PLAN A ELECTRICAL LAYOUT E003 PARTIAL PLAN B ELECTRICAL LAYOUT E004 PARTIAL PLAN C ELECTRICAL LAYOUT E005 PARTIAL PLAN D ELECTRICAL LAYOUT E006 PARTIAL PLAN E ELECTRICAL LAYOUT E007 PARTIAL PLAN F ELECTRICAL LAYOUT E008 PARTIAL PLAN G ELECTRICAL LAYOUT E009 PARTIAL PLAN H ELECTRICAL LAYOUT E010 DETAILS E011 DETAILS


E012 DETAILS

E013 DETAILS E014 DETAILS

GENERAL NOTES 1. ALL WORK SHALL COMPLY WITH MOST RECENT EDITION OF THE NESC. 2. POLE LOCATIONS AND POLE FRAMING AND GUYING MAY BE FIELD ADJUSTED TO ACCOMMODATE RIGHT-OF-WAY CONFLICTS NOT EVIDENT PRIOR TO CLEARING. 3. NEUTRAL SHALL NOT CROSS PRIMARY IN ANY SPAN. 4. PROVIDE ALL ANCHOR PLACEMENTS AT


1:1 MEASURED AT THE UPPERMOST GUY ATTACHMENTS, UNLESS OTHERWISE NOTED. 5. SOURCE IS NEW POWER PLANT; FRAME DOUBLE DEADEND POLES WITH THE SOURCE DEADEND ABOVE.


6. SEE E014 FOR DETAIL SCHEDULE OF STANDARD RUS DETAIL REFERENCES FOR DETAILS USED, BUT NOT DRAWN FOR THIS PROJECT.

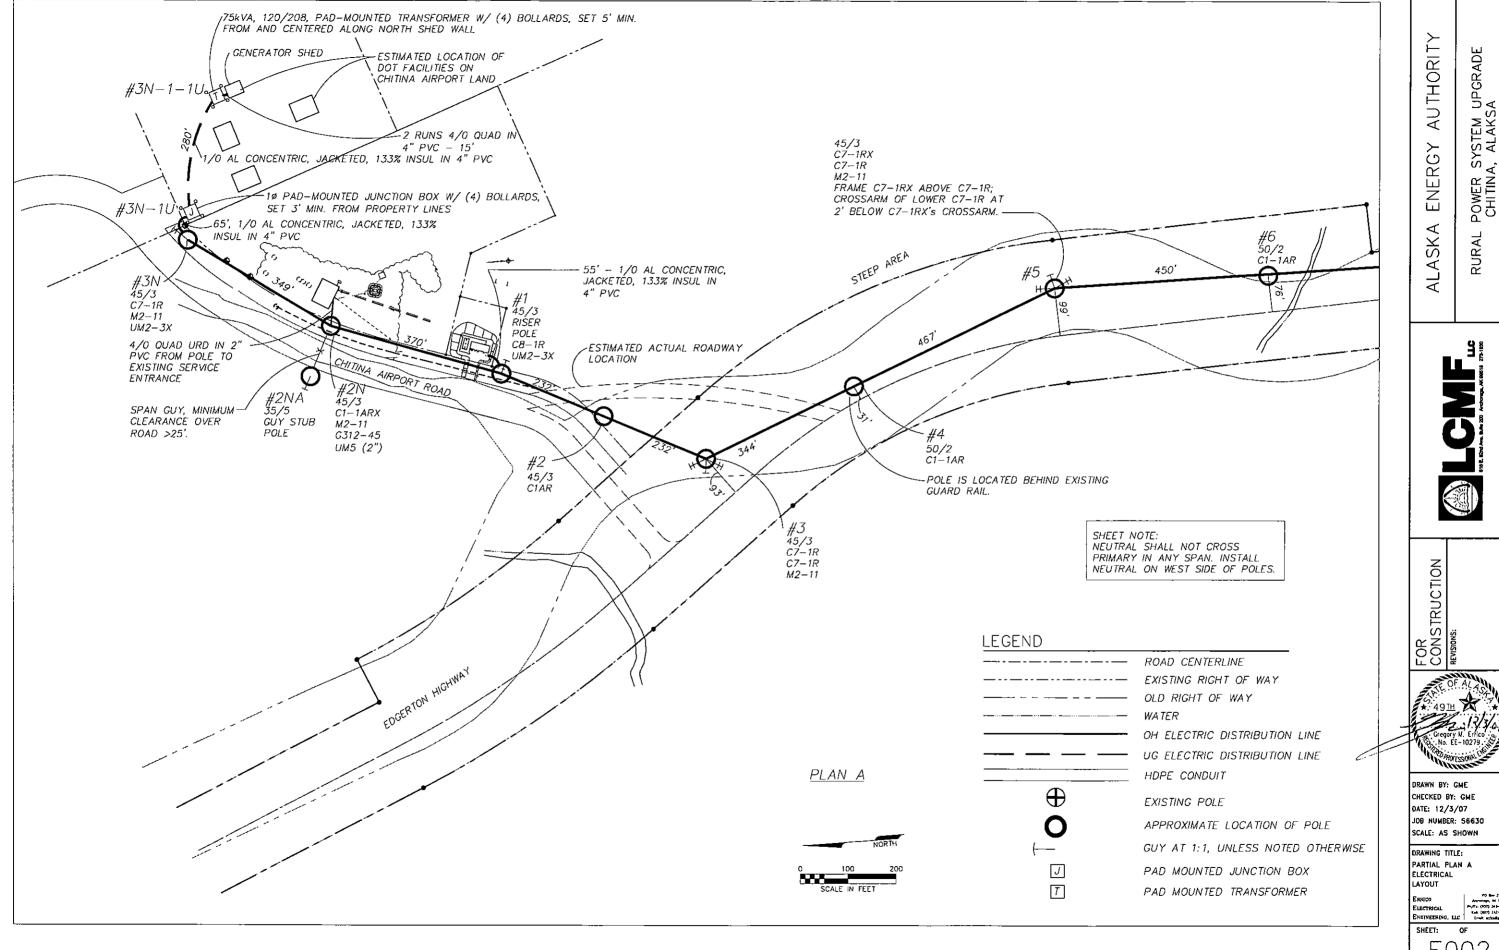




CHECKED BY: GME JOB NUMBER: 56630 SCALE: AS SHOWN

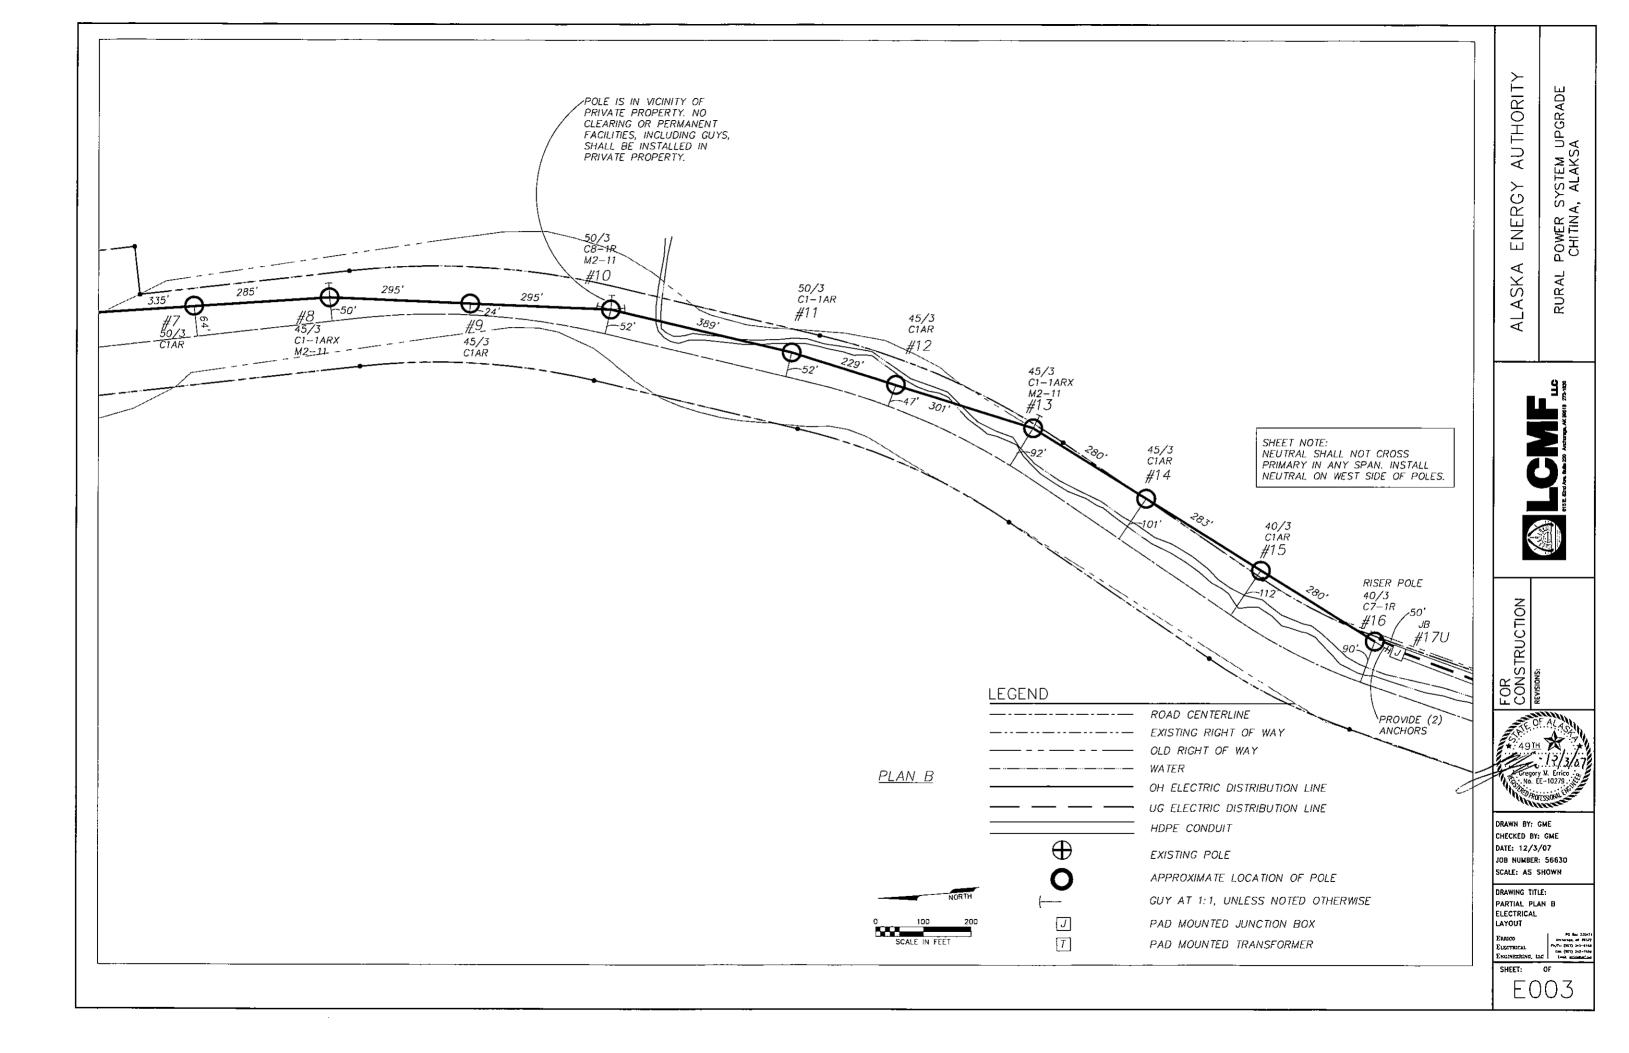

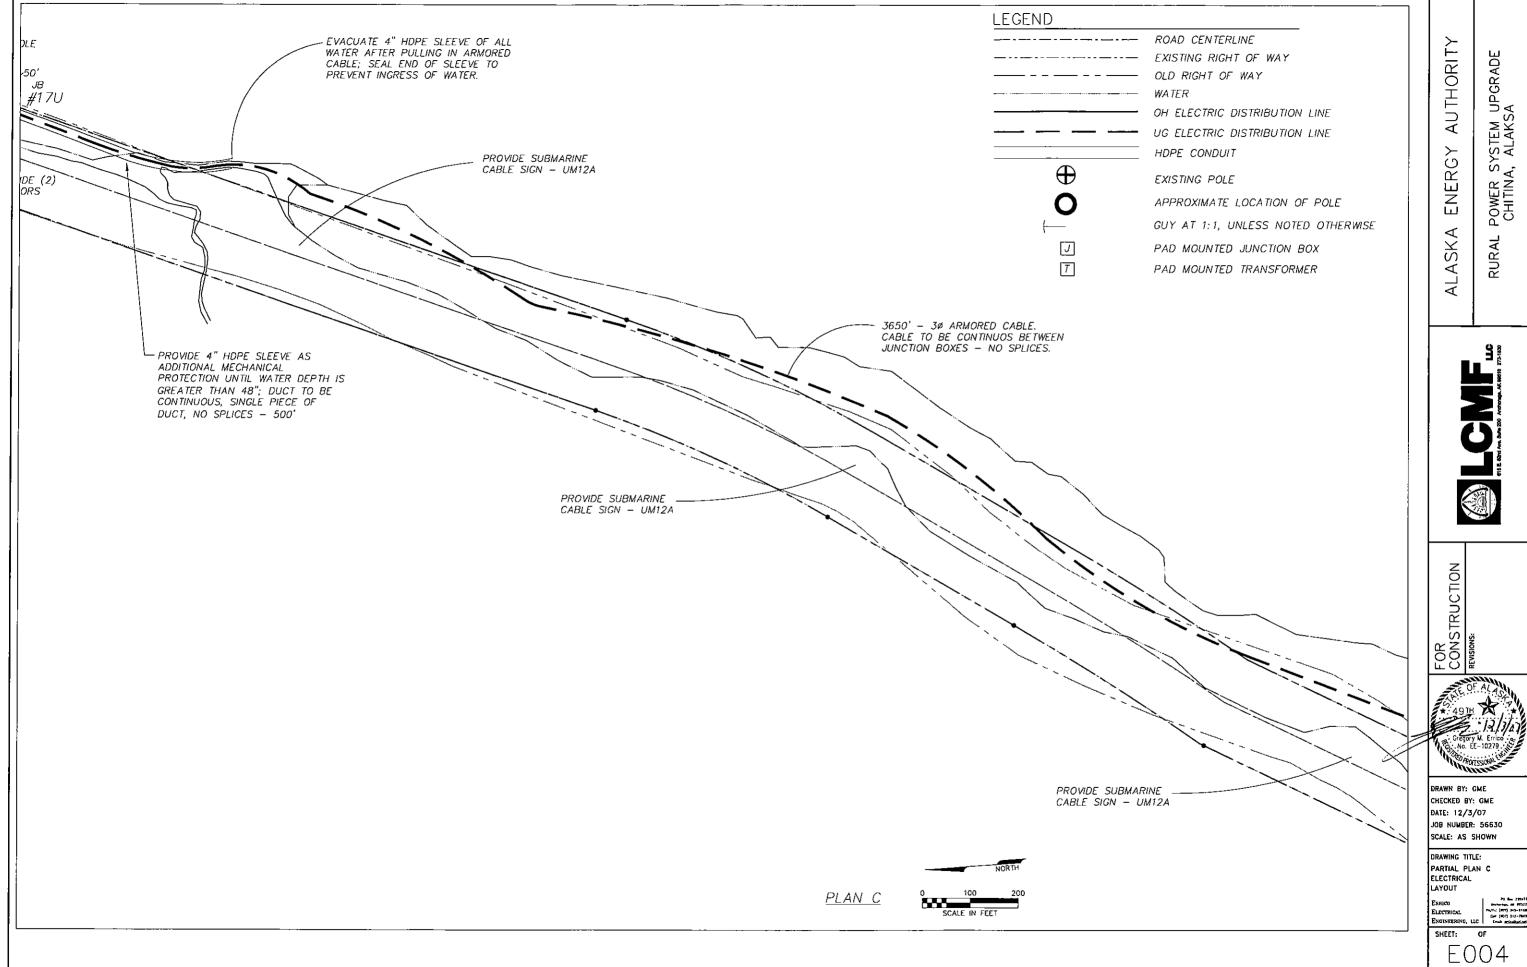

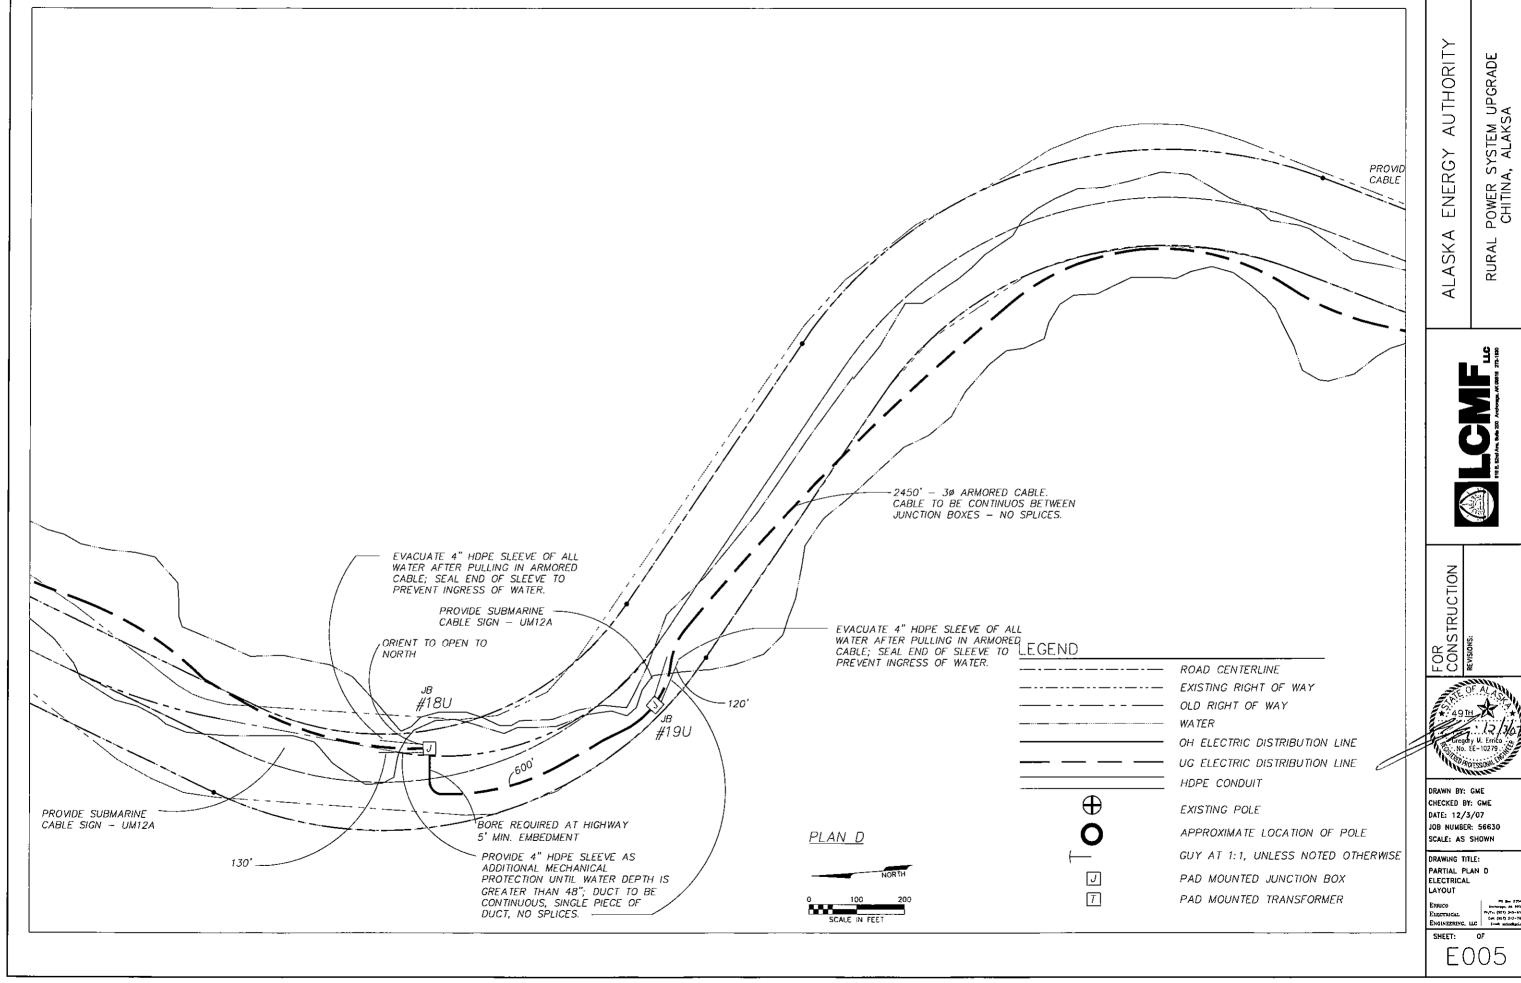





DRAWN BY: GME
CHECKED BY: GME
DATE: 12/3/07
JOB NUMBER: 56630
SCALE: AS SHOWN


DRAWING TITLE: PARTIAL PLAN E ELECTRICAL


ERRICO
ELECTRICAL
ENGINEERING, 110

HEET: OF

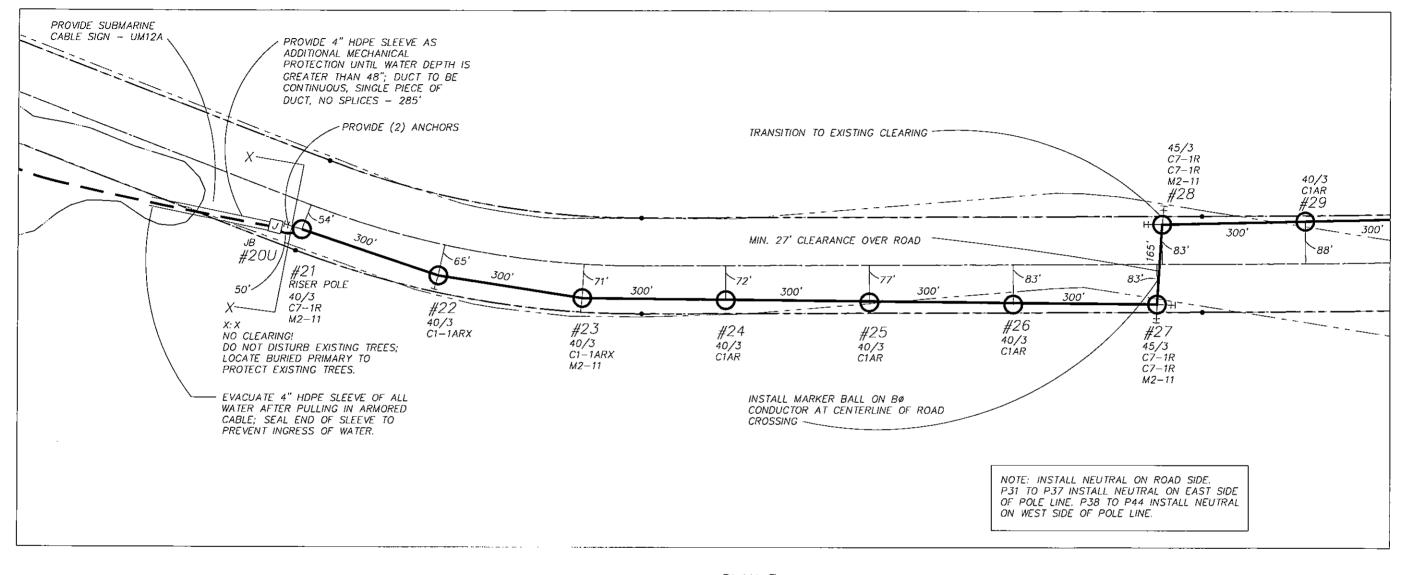


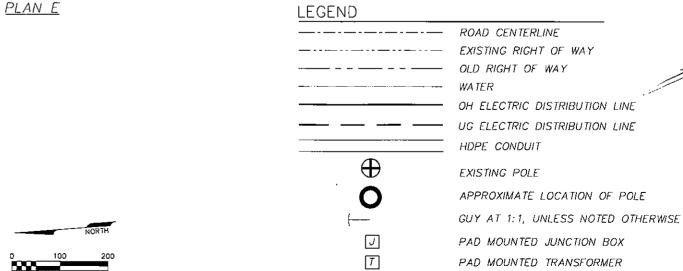

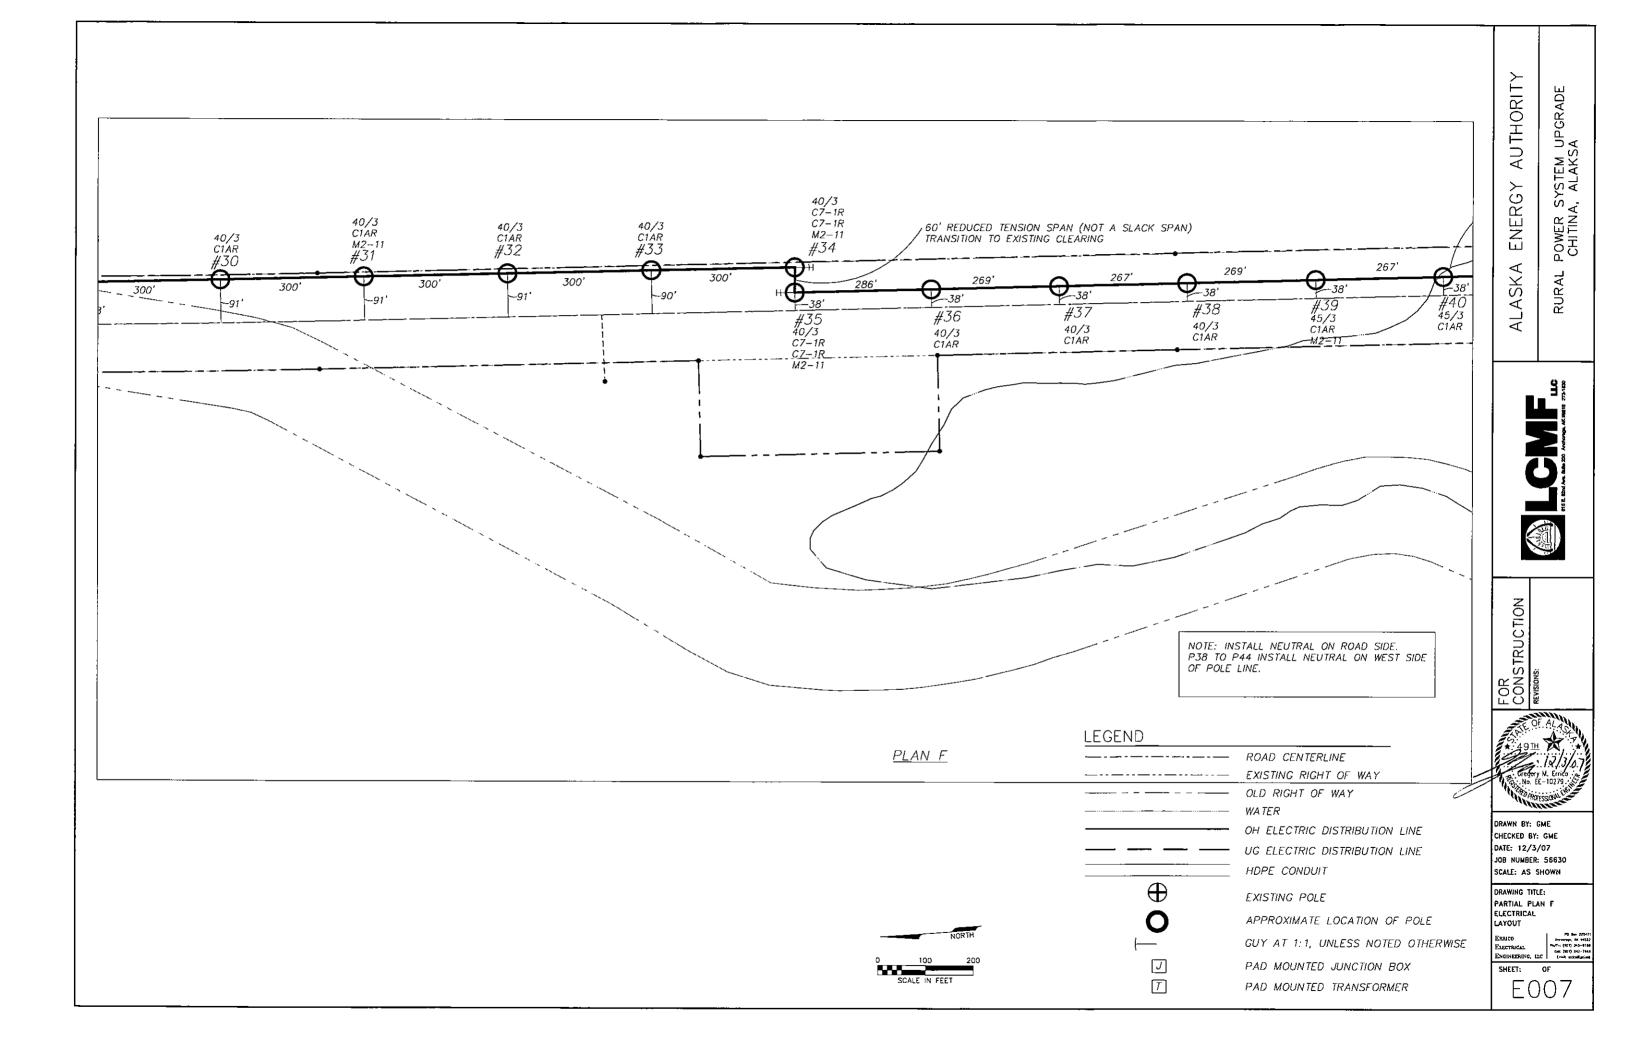

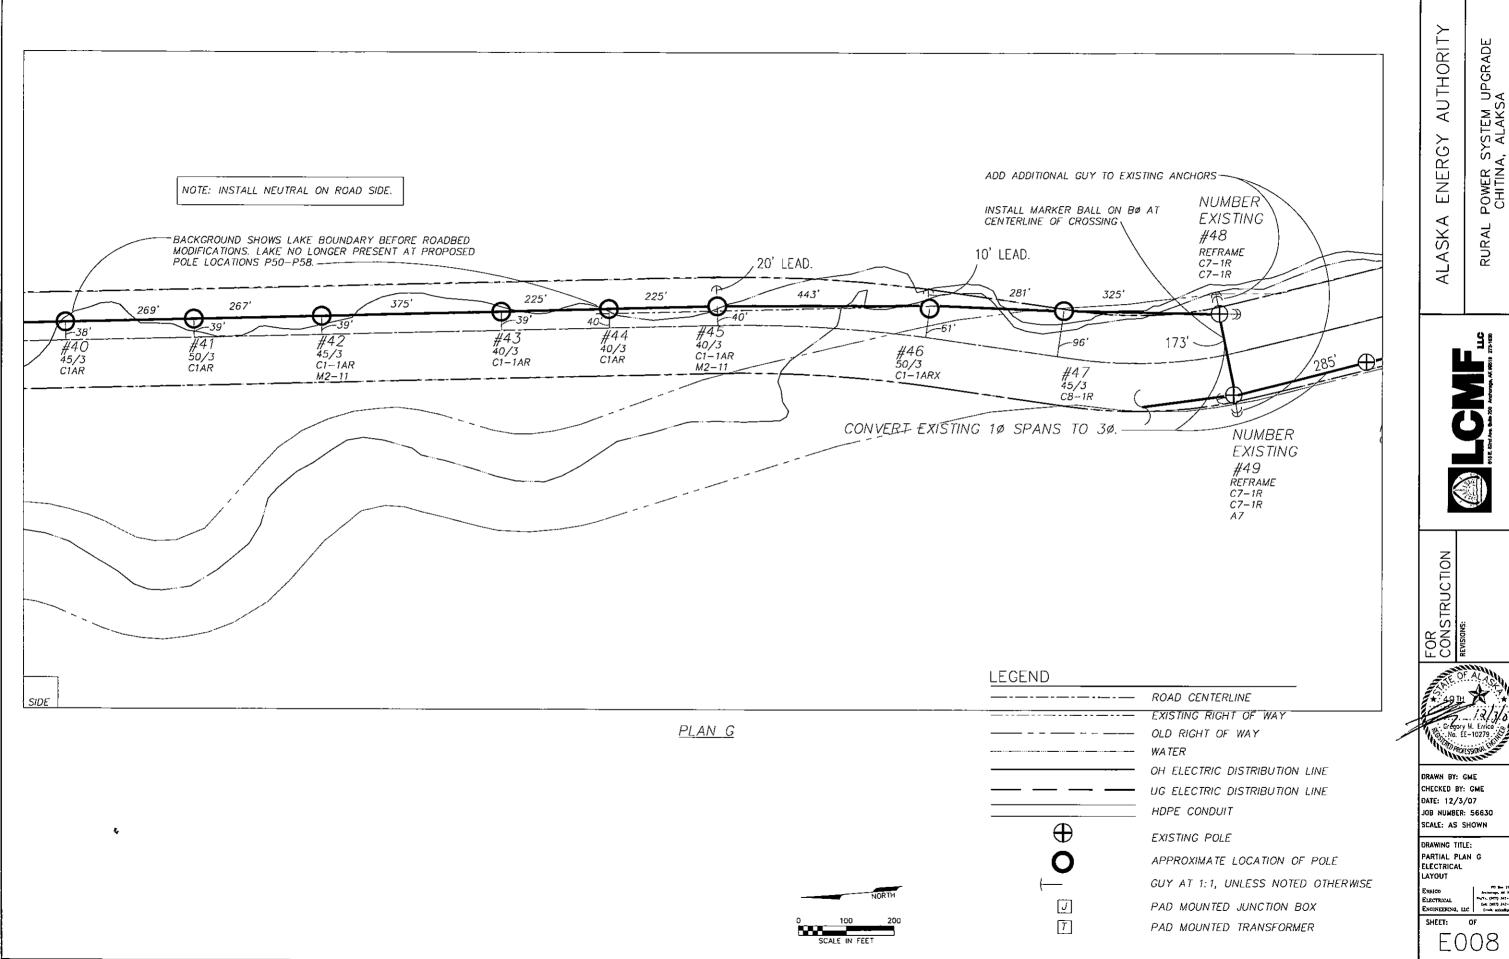



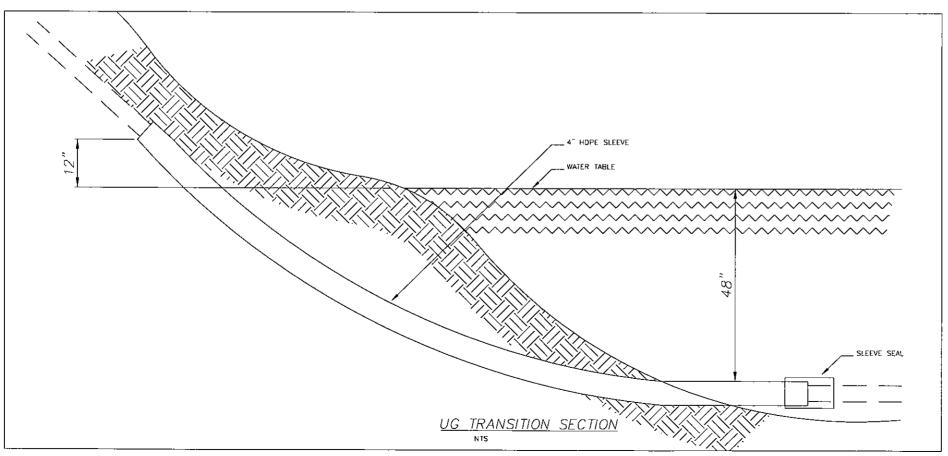

LEGEND	
	ROAD CENTERLINE
	EXISTING RIGHT OF WAY
	OLD RIGHT OF WAY
	WATER
	OH ELECTRIC DISTRIBUTION LINE
	UG ELECTRIC DISTRIBUTION LINE
	HDPE CONDUIT
\oplus	EXISTING POLE
0	APPROXIMATE LOCATION OF POLE
	GUY AT 1:1, UNLESS NOTED OTHERWISE
J	PAD MOUNTED JUNCTION BOX
T	PAD MOUNTED TRANSFORMER

AUTHORITY

ENERGY

ALASKA

POWER SYSTEM UPGRADE CHITINA, ALAKSA

FOR CONSTRUCTION




DRAWN 8Y: GME
CHECKED BY: GME
DATE: 12/3/07
JOB NUMBER: 55630
SCALE: A5 SHOWN

DRAWING TITLE: PARTIAL PLAN H ELECTRICAL LAYOUT


ERRICO
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EET: OF

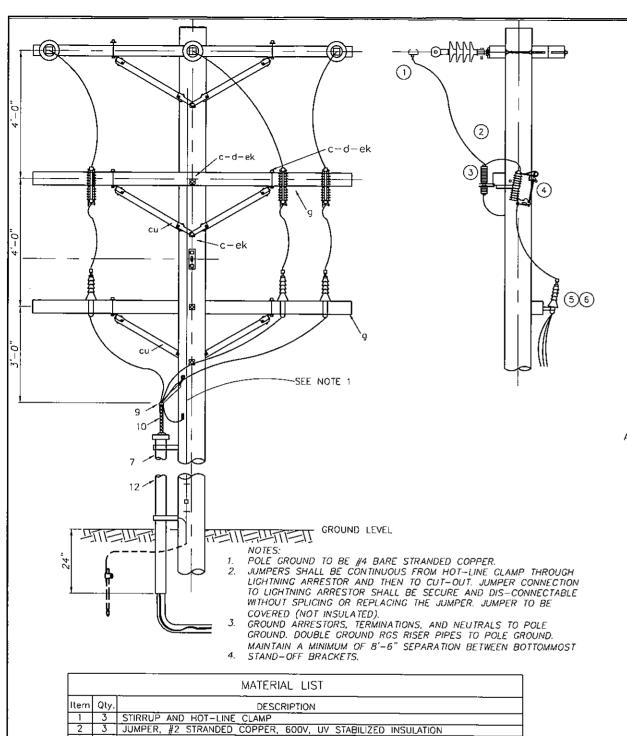


		MATERIAL LIST
Item	Qty.	DESCRIPTION
1	3	STIRRUP AND HOT-LINE CLAMP
2	3	JUMPER, #2 STRANDED COPPER, 600V, UV STABILIZED INSULATION
3	3	SURGE ARRESTOR
4	3	CUT OUT. LOAD BREAK, W/ FUSE OR SOLID BLADE
5	3	TERMINATION, 15 KV
6	3	TERMINATION MOUNTING BRACKET WITH HARDWARE
7	ıs reqid	4" PVC (BELL ENDS ORIENTED DOWNWARD), TOP PIECE WITH BELL END BUSHING
8	os regid	4" CONDUIT STRAPS
9	2	TRI-FURCATING CONDUIT COMPRESSION SEALING BOOT
10	2	KELLUM GRIP
11	os regid	STAND-OFF BRACKET
12	1	4" RGS CONDUIT (15')
13		SCREW LAG 1/2" X 4", (os required)
14	2	PIPE GROUNDING CLAMP
15	-	NO. 4 STRANDED COPPER, EQUIPMENT GROUNDING, (as required)
16	-	COPPER COMPRESSION CONNECTORS, (as required)
9	2	CROSSARM, 3-5/8" X 4-5/8" X 10'-0"
С	2	BOLT, MACHINE, 5/8 X REQ'D LENGTH
ď	4	WASHER, 2-1/4" SQUARE WITH 13/16" HOLE
cu	4	BRACE, WOOD 28"
i	_4	BOLT, CARRIAGE, 3/8" X REQ'D LENGTH
ęk		LOCKNUTS, (as required)

3) <u>UM2-3X: THREE PHASE RISER</u> NTS

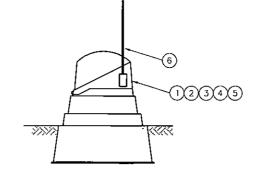

		MATERIAL LIST
ITEM	QTY	DESCRIPTION
1	1	FIBERGLASS JUNCTION ENCLOSURE: POWER DESIGN
		INC. PART#CJP-33/S-50-L2-MG, OR APPROVED EQUAL
2	1	3/4" COPPER CLAD STEEL RODS
3	1	GROUND ROD CLAMP
4		#4 BARE STRANDED COPPER, AS REQUIRED
5	3	THREE-POSITION JUNCTIONS
6	1.	SNOW MARKER

4 UM3-02 JUNCTION BOX

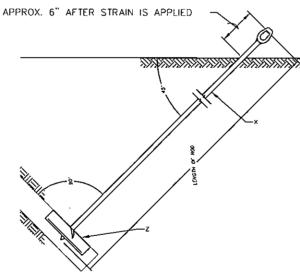


	QUANTITY	ANCHOR TYPE - STEEL PLATE ULTIMATE CAPACITY, CLASS 6 SOIL 16,000 LBS.	
-	1	ANCHOR - PLATE, 400 SQ, IN	
	1	ROD, ANCHOR, TRIPLE EYE	

- 1. RECOMMENDED MINIMUM PROJECTION AFTER PRELOADING IS 6 INCHES. PROJECTION MAY BE INCREASED TO AVOID OVERTOROUING OF THE SHAFT.

 2. THE ANCHOR ROD, NUTS, AND PLATE SHALL BE HOT DIPPED GALVANIZED IN ACCORDANCE WITH ASTM A153.
- CONTRACTOR SHALL INSTALL ANCHORS IN ACCORDANCE WITH MANUFACTURER'S RECOMMENDATIONS.

	MATERIAL LIST
NQ.	DESCRIPTION
x	ROD, ANCHOR, TWIN EYE, 3/4" x 8'-0"
Z	ANCHOR, PLATE, 400 SQ. IN.

2)F1-4P: PLATE ANCHOR

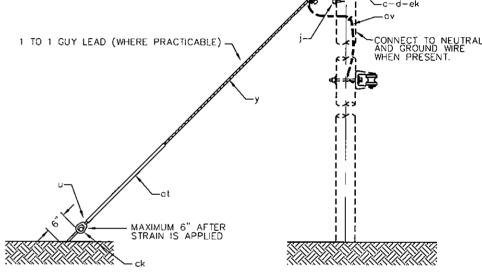

- 1. FORMED TYPE GRIPS MAY BE USED ONLY WITH SUITABLE ATTACHMENTS, (ITEM V) RECOMMENDED BY GRIP MANUFACTURER.
- WHERE SEPARATE ANCHORS ARE INSTALLED THE MINIMUM SEPARATION SHALL BE FIVE FEET.
- SPACING BETWEEN ANCHORS SHALL BE SUFFICIENT TO PROVIDE MAXIMUM HOLDING POWER OF EACH ANCHOR.
- 4. FOR LOOSE SOILS, CONCRETE OR OTHER, POLE FOOTINGS MAY BE

		MATERIAL LIST
Item	QTY	DESCRIPTION
_ ¢ .	. 1	BOLT, MACHINE, 3/4" X REQ'D LENGTH
d	11	WASHER, 4" SQUARE, 3/8 THICK, CURVED WITH 13/16" HOLE
ek	1	LOCKNUTS, 3/4:
j	1_	SCREW, LAG 1/2' x 4"
Р		CONNECTORS, COMPRESSION, AS REQUIRED
น	2	DEADEND, PREFORMED, GUY
>	1	GUY ATTACHMENT (8,500 lbs.)
у		GUY STRAND, 3/8", GALVANIZED STEEL STRAND, EHS, AS REQUIRED
al		STAPLES, GROUND WIRE, AS REQUIRED
av		JUMPERS, GOUNDING, AS REQUIRED. #6 BARE SOLID COPPER
at		GUY MARKER, 96" (ORANGE AND YELLOW OR SOLID ORANGE)
ck	1	CLAMP, ANCHOR ROD, BONDING

1)E1-3: SINGLE DOWN GUY

AUTHORITY POWER SYSTEM UPGRADE CHITINA, ALAKSA ENERGY ASKA AL,



DRAWN BY: GME CHECKED BY: GME DATE: 12/3/07 JOB NUMBER: 56630 SCALE: AS SHOWN

DRAWING TITLE: DETAILS





DRAWN BY: GME
CHECKED BY: GME
DATE: 12/3/07
JOB NUMBER: 56630
SCALE: AS SHOWN


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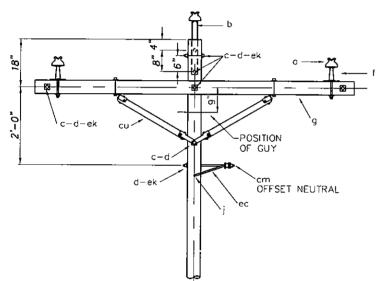
Errico Electrical Engineering, ilc


SHEET: C



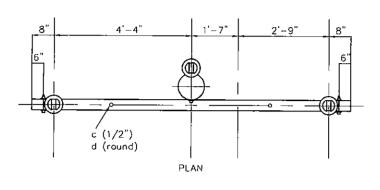

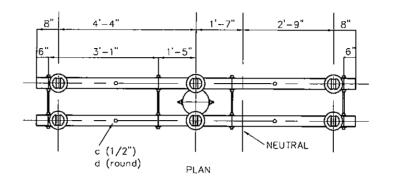

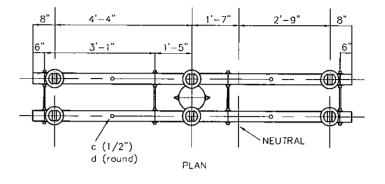

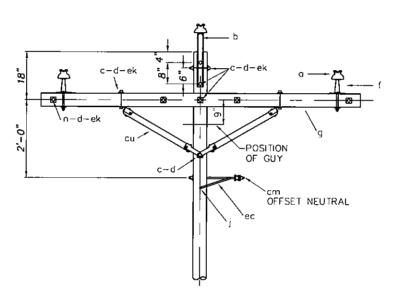


2'-0" 18"	c-d-ek to to	c-d-ek a g
<u> </u>	c-d oox FOR NEUTRAL AT C1-1ARXX ek d (3" square curved)	OF GUY OG-O-CM OFFSET NEUTRAL

		MATERIAL LIST
NO.	Oty.	DESCRIPTION
а	3	INSULATOR, PIN TYPE, ANSI 55-4
σ	1	PIN, pole top, 20", straight or offset
С	7	BOLT, MACHINE, 5/8 X REQ'D LENGTH
С	2	BOLT, MACHINE, 1/2"XREQ'D LENGTH
į.	2	SCREW, LAG, 1/2" X 4"
ď	2	WASHER, 1-3/8" ROUND WITH 9/16" HOLE
ď	12	WASHER, 2-1/4" SQUARE WITH 13/16" HOLE
ſ	2	PIN, CROSSARM, STEEL, CLAMP TYPE
g.	1	CROSSARM, 3-3/4" X 4-3/4" X 10'-0"
cu	1	BRACE, WOOD, 60" SPAN, PAIR
cm	_ i	INSULATOR, SPOOL, 3"
еc	. 1	BRACKET, OFFSET NEUTRAL
ek	2	LOCKNUT 1/2"
ek	8	LOCKNUT, 5/8"
- 1	4	ARMOR ROD
- 1	3	PREFORMED TANGENT TIE
- 1	1	PREFORMED NEUTRAL TANGENT TIE

		MATERIAL LICT
		MATERIAL LIST
NO.	Qly.	DESCRIPTION
. a	6	INSULATOR, PIN TYPE, ANSI 55-4
b	2	PIN, pole top, 20", straight or offset
¢	1	BOLT, MACHINE, 5/8 X REQ'D LENGTH
С	4	BOLT, MACHINE, 1/2"XREQ'D LENGTH
ρ	4	WASHER, 1-3/8" ROUND WITH 9/16" HOLE
d	20	WASHER, 2-1/4" SQUARE WITH 13/16" HOLE
f	4	PIN, CROSSARM, STEEL
g	2	CROSSARM, 3-3/4" X 4-3/4" X 10'-0"
j	2	SCREW, LAG, 1/2" X 4"
n	6	BOLT, DOUBLE ARMING, 5/8" x REQUIRED LENGTH
cu	2	BRACE, WOOD, 60" SPAN, PAIR
cm		INSULATOR, SPOOL, 3"
ec	1	BRACKET, OFFSET NEUTRAL
ek	4	LOCKNUT 1/2"
ek	_ 20	LOCKNUT, 5/8"
0	1	NUT, EYE. 5/8"
00	_ 1	LARGE CLEVIS
-	3	ARMOR ROD FOR DOUBLE PIN
-1	3	PREFORMED WIRE DOUBLE PIN TANGENT TIE
- 1	1	ARMOR ROD
-	1	PREFORMED NEUTRAL SPOOL TANGENT TIE

		MATERIAL LIST
NO.	Qty.	DESCRIPTION
а	6	INSULATOR, PIN TYPE, ANSI 55-4
b	2	PIN, pole top, 20", straight or offset
С	1	BOLT, MACHINE, 5/8 X REO'D LENGTH
С	4	BOLT, MACHINE, 1/2"XREQ"D LENGTH
ď	4	WASHER, 1-3/8" ROUND WITH 9/16" HOLE
d	20	WASHER, 2-1/4" SQUARE WITH 13/16" HOLE
d :	1	WASHER, 3" SQUARE CURVED WITH 13/16" HOLE
f	4	PIN, CROSSARM, STEEL
g	2	CROSSARM, 3-3/4" X 4-3/4" X 10'-0"
	2	SCREW, LAG, 1/2" X 4"
ָר	6	BOLT, DOUBLE ARMING, 5/8" x REQUIRED LENGTH
c	2	BRACE, WOOD, 60" SPAN, PAIR
с'n	1	INSULATOR, SPOOL, 3"
ec	1	BRACKET, OFFSET NEUTRAL (C1-1ARX ONLY)
ek	4	LOCKNUT 1/2"
ek	20	LOCKNUT, 5/8"
0	-	NUT, EYE. 5/8"
oo	_	LARGE CLEVIS (C1-TARX ONLY)
	3	ARMOR ROD FOR DOUBLE PIN
-	3	PREFORMED WIRE DOUBLE PIN SIDE TIE
-	1	ARMOR ROD
	1	PREFORMED NEUTRAL SPOOL ANGLE TIE
aax	1 .	LARGE RIGID CLEVIS (C1-1ARXX ONLY)

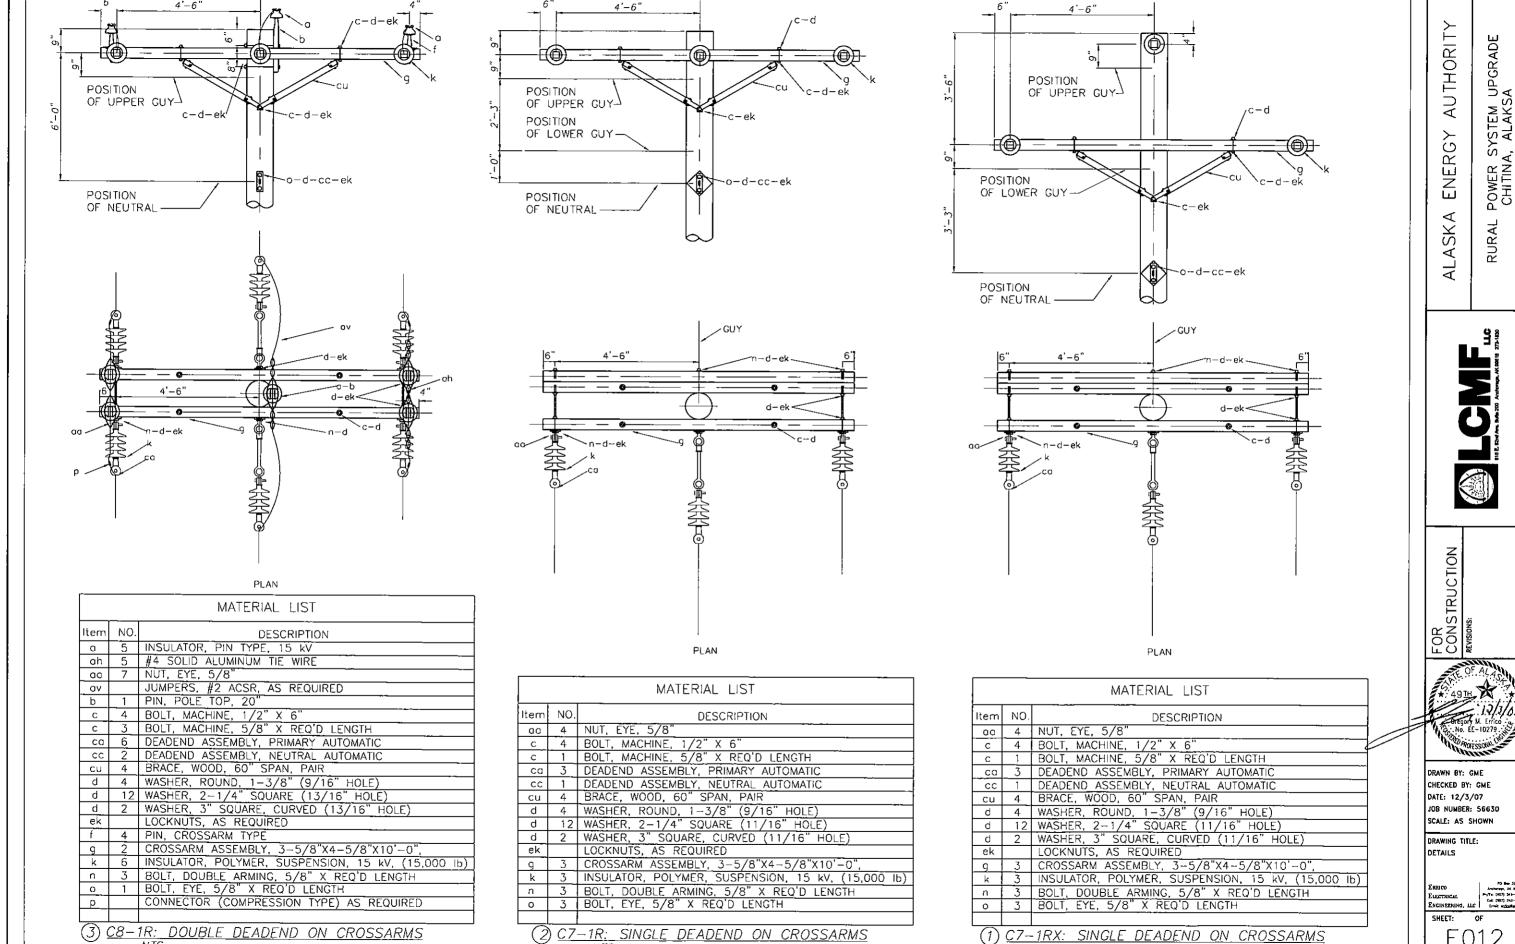

C7-1R: SINGLE DEADEND ON CROSSARMS

NTS

NTS



JOB NUMBER: 56630




DRAWN BY: GME CHECKED BY: GME DATE: 12/3/07 JOB NUMBER: 56630 SCALE: AS SHOWN

DETAILS


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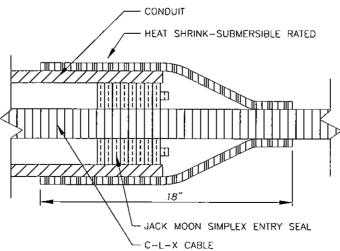
E013

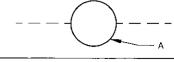

		MATERIAL LIST
Item	NO.	DESCRIPTION
Α	1	MARKER BALL, RED, 20" DIA., SECURED TO PRIMARY WITH PRE-FORMED HELICAL TIE

(2) MARKER BALL NTS




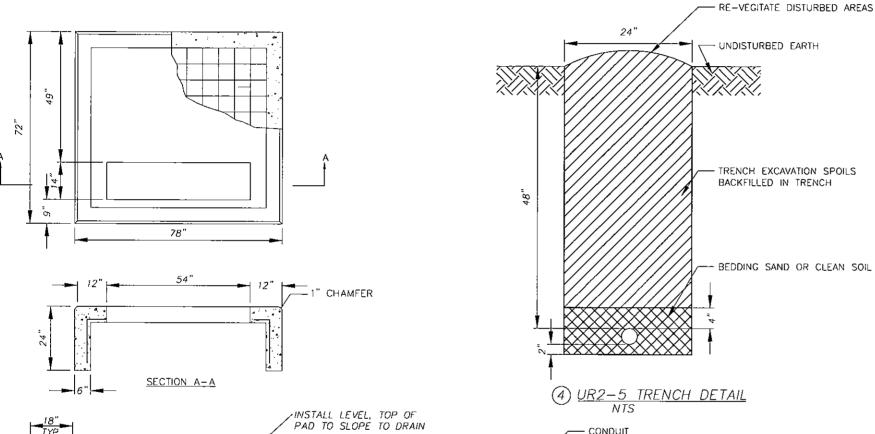

		MATERIAL LIST
tem	Qty.	DESCRIPTION
Jja	1	PAD, CONCRETE, PRE-MANUFACTURED
\neg	5	GRAVEL, D1 OR RECYCLED/CRUSHED
		CONCRETE, 1" MINUS, CU. YD.

(5) UM1B: PAD, 3-PHASE TRANSFORMER

(3) CONDUIT SLEEVE SEAL NTS

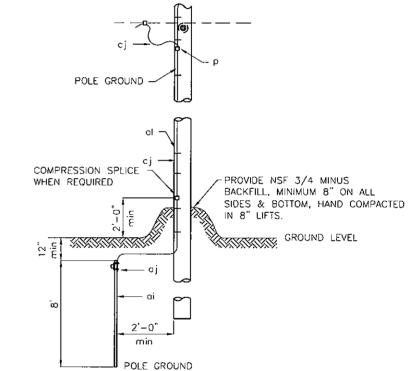

NOTES:

1. POLE GROUND WIRE TO BE LOCATED ON SAME SIDE AS NEUTRAL CONDUCTOR AND IN QUADRANT OPPOSITE CLIMBING SPACE AND ON ONE SIDE OF RISER.

2. STAPLES ON GROUND WIRES SHALL BE 2'-0" APART. EXCEPT FOR A DISTANCE OF 8'-0" ABOVE GROUND AND 8'-0" FROM TOP OF POLE, WHERE THEY SHALL BE 6" APART.


3. GROUND WIRE TO CLEAR ALL HARDWARE BY 2" MINIMUM, AND SHALL BE STAPLED TO MAINTAIN THIS POSITION.
4. GROUND ARRESTORS, TERMINATIONS, ALUMAFORM BRACKET AND RISER PIPE TO POLE GROUND.
5. DOUBLE GROUND RISER PIPE TO POLE GROUND.

MATERIAL LIST				
Item	NO.	DESCRIPTION		
р	as reg'd	CONNECTOR, COMPRESSION		
ai	1	ROD, GROUND, COPPER-CLAD STEEL, 5/8" MIN. X 8'		
aj	ì	EXOTHERMIC WELD TO GROUND ROD		
a!	AS REQ'D	STAPLES, COPPER		
ol	1	GROUND WIRE CLIP		
cj	AS REQ'D	GROUND WIRE, #6 COPPER		
αv	AS REO'D	JUMPER, COPPER		

1) M2-11: POLE GROUND NTS


DRAWING TITLE: DETAILS

E014

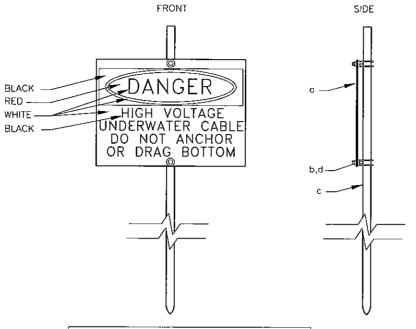

MATERIAL LIST						
Item	Qty.	DESCRIPTION				
0	1	WARNING SIGN, 10"X14"				
b.	2	CLAMP, GROUND ROD				
С	1	GROUND ROD, 3/4"X8' GALV.				
ď	2	WASHER, ROUND, 3/8"				

(4) UM12A: WARNING SIGN, UNDERWATER CABLE

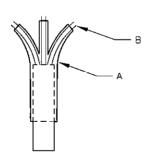


HEAT-SHRINK TRIFURCATING CABLE BREAKOUT BOOT FOR C-L-X CABLE

MATERIAL LIST					
Item	Qty.	DESCRIPTION			
Α :	1	TRIFURCATING BREAKOUT BOOT KIT, RAYCHEM PART # MOD-3A-HVT			
В	AS REQ	UNCOATED REJACKETING TUBING, RAYCHEM PART # MWTM-35/12-1200U			


(5) TRIFURCATING BREAKOUT BOOT DETAIL

DETAIL SCHEDULE OF STANDARD RUS ASSEMBLIES						
Item	DESCRIPTION					
A7	SINGLE-PHASE DEADEND ASSEMBLY					
E2-3	SPAN GUY					
G312-45	THREE-PHASE TRANSFORMER BANK					
M52-3	POLE NUMBER					
R1-16	CLEARING UNDERGROUND 16					
R1-30	CLEARING OVERHEAD 30'					
UG17-3	3-PHASE PAD MOUNTED LOOP FEED TRANSFORMER WITH RADIAL FEED					
UM5	SECONDARY CABLE TERMINAL POLE					
UM6-1	LOAD BREAK ELBOW (200A)					
UM6~6	GROUND ROD ASSEMBLY					
UM6-15	STAND-OFF INSULATOR (200A)					

(1) RUS STANDARD DETAIL SCHEDULE FOR DETAILS NOT SHOWN IN DRAWING SET

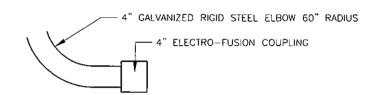

(2) ELECTROFUSION COUPLING TO HDPE

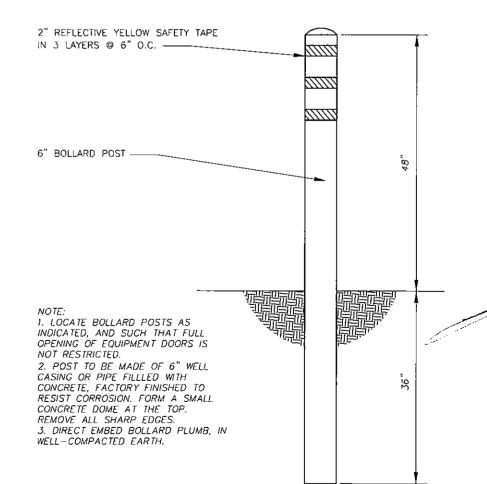

3 BOLLARD DETAIL
NTS